#### NOTES

SHEET #	DRAWING	ISSUE	PRINT SET	
L-01	COVER / DRAWING INDEX	2/3/12	2/20/12	
A-01	EXISTING FOUNDATION PLAN	"	2/20/12	
A-02	EXISTING 1ST FLOOR PLAN	"	2/20/12	
A-03	EXISTING 2ND FLOOR PLAN	"	2/20/12	
A-04	PROPOSED 1ST FLOOR PLAN	"	2/20/12	
A-05	PROPOSED 2ND FLOOR PLAN	u	2/20/12	
A-06	NOT USED			
A-07	SCHEDULES: NOTES	"	2/20/12 2/20/12 2/20/12	
A-08	FRONT ELEVATION			
A-09	LEFT ELEVATION	II .		
A-10	REAR ELEVATION	II	2/20/12	
S-01	1ST FLOOR FRAMING	II	2/20/12	
S-02	2ND FLOOR FRAMING	п	2/20/12	
S-03	WALL BRACING PLAN —	II .	2/20/12	
S-04	ROOF FRAMING	ıı .	2/20/12	
S-05	SECTION A-A	"	2/20/12	
S-06	BRACED WALL FRAMING DETAIL	" 2/20/1		

SCOPE:

TO ADD A BATHROOM OVER REAR OF EXISTING GARAGE. TO INCREASE 2ND FLOOR AREA BY ADDING A SECOND STORY ABOVE EXISTING GARAGE STRUCTURE.

SEE SWANSON STRUCTURAL INC. LETTER REPORT; 2/18/12



PROPOSED STRUCTURE

## Savage Residence

15 Evans Road

Needham, MA

## Roger P. Toran

DESIGN ~ BUILD

57 Mary Chilton Road Needham, Massachusetts 02492 781-444-5966 781-449-6727 FAX

Job Number: 0911

Drawn By: Roger P. Toran

Date: 20 June 2011

Revised: 20 Feb. 2012

Scale: 1/4" = 1'

## DRAWING INDEX




L-01



**EXISTING STRUCTURE** 



Existing garage foundation has been excavated and verified that it extends down 4' below existing grade.

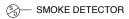

Smoke detector location to be verified by builder and by Fire dept.

All Smoke detectors to be interconnected with battery backup and CO detection.

Builder to provide 5/8" firecode board to isolate garage wood structure from living space

#### Savage Residence 15 Evans Road

Needham, MA

## Roger P. Toran

DESIGN ~ BUILD

57 Mary Chilton Road Needham, Massachusetts 02492 781-444-5966 781-449-6727 FAX

Job Number: 0911

Drawn By: Roger P. Toran


Date: 20 June 2011

Revised: 20 Feb. 2012

Scale: 1/4" = 1'

# EXISTING FOUNDATION PLAN



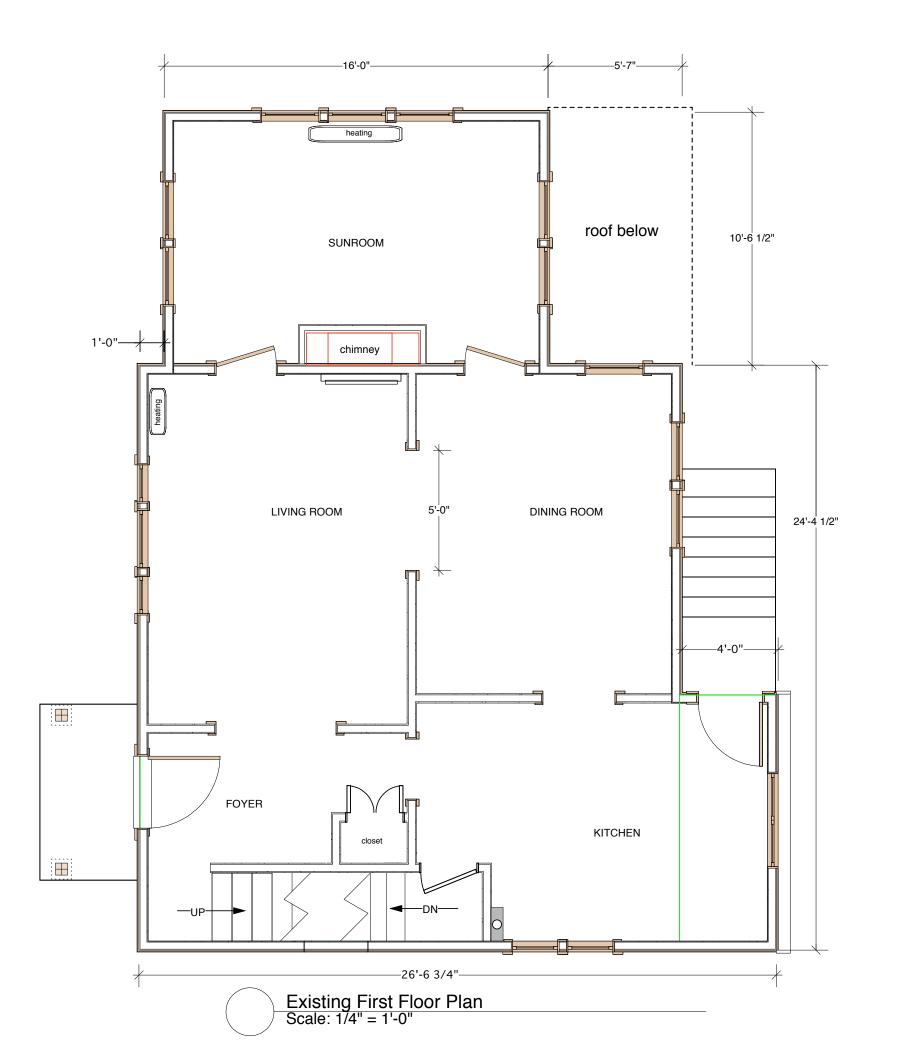

Needham, MA

# Roger P. Toran

DESIGN ~ BUILD

57 Mary Chilton Road Needham, Massachusetts 02492 781-444-5966 781-449-6727 FAX

Job Number: 0911

Drawn By: Roger P. Toran


Date: 20 June 2011

Revised: 20 Feb. 2012

Scale: 1/4" = 1'

# EXISTING FIRST FLOOR PLAN



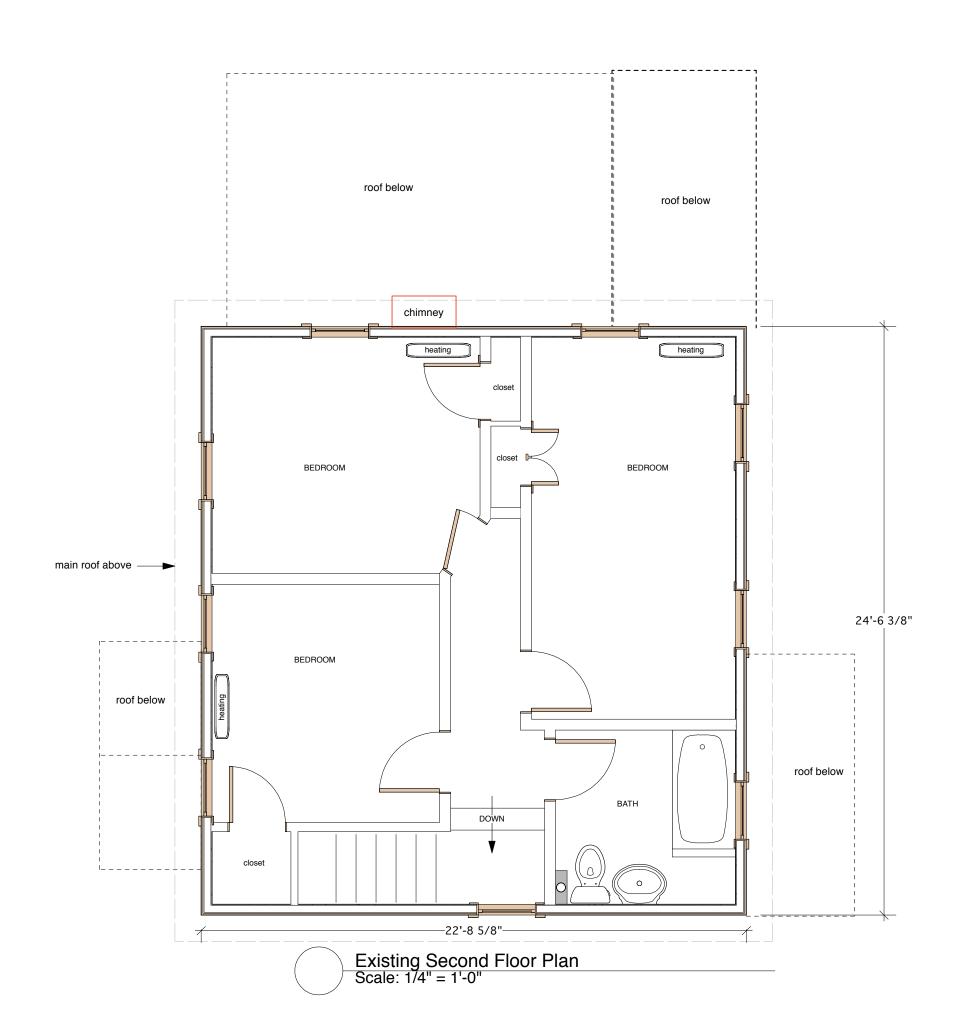

Needham, MA

## Roger P. Toran

DESIGN ~ BUILD

57 Mary Chilton Road Needham, Massachusetts 02492 781-444-5966 781-449-6727 FAX

Job Number: 0911

Drawn By: Roger P. Toran


Date: 20 June 2011

Revised: 20 Feb. 2012

Scale: 1/4" = 1'

## EXISTING 2ND FLOOR PLAN



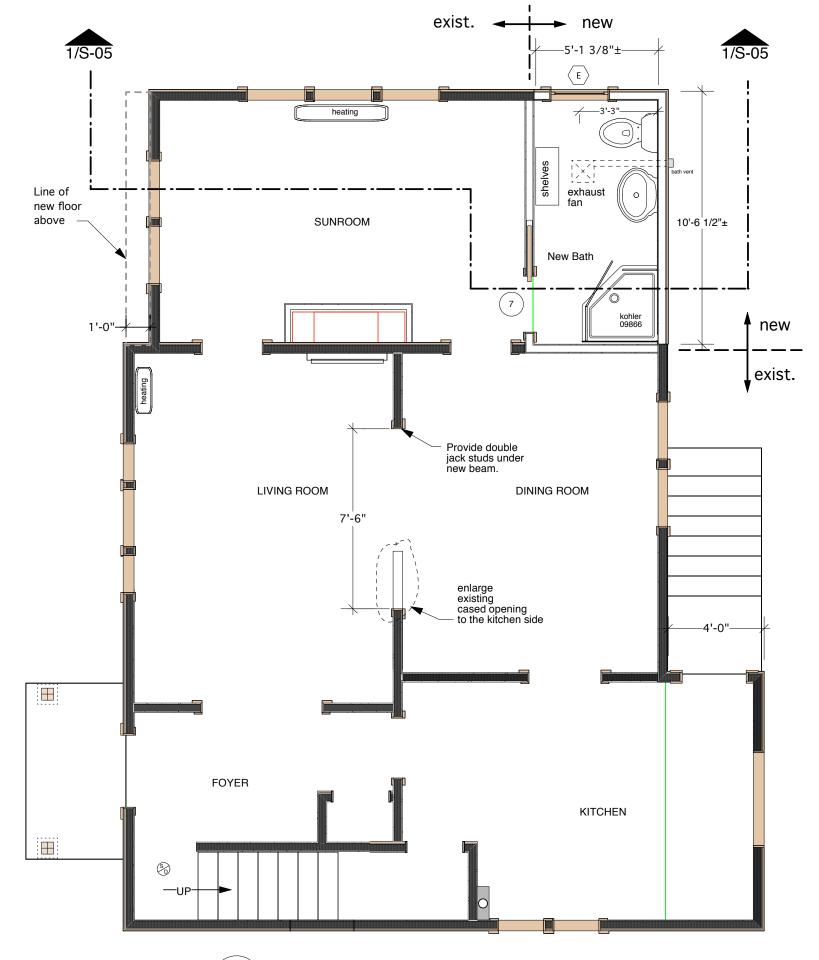

Proposed First Floor Plan Scale: 1/4" = 1'-0"

Bath to have fan light combo.

exhausted to outside air.

Bathroom door type to be determined between builder

SMOKE DETECTOR

and homeowner

Smoke detector location to be verified by builder and by Fire dept.

All Smoke detectors to be interconnected with battery backup and CO detection.

Due to age of house it is assumed to have windbraces on existing walls. This can only be verified after start of project.

All new wall construction shall be constructed in accordance with 780 CMR 56

Savage Residence 15 Evans Road

Needham, MA

#### Roger P. Toran

DESIGN ~ BUILD

57 Mary Chilton Road Needham, Massachusetts 02492 781-444-5966 781-449-6727 FAX

Job Number: 0911

Drawn By: Roger P. Toran


Date: 20 June 2011

Revised: 20 Feb. 2012

Scale:

1/4" = 1'


**PROPOSED 1ST FLOOR PLAN** 

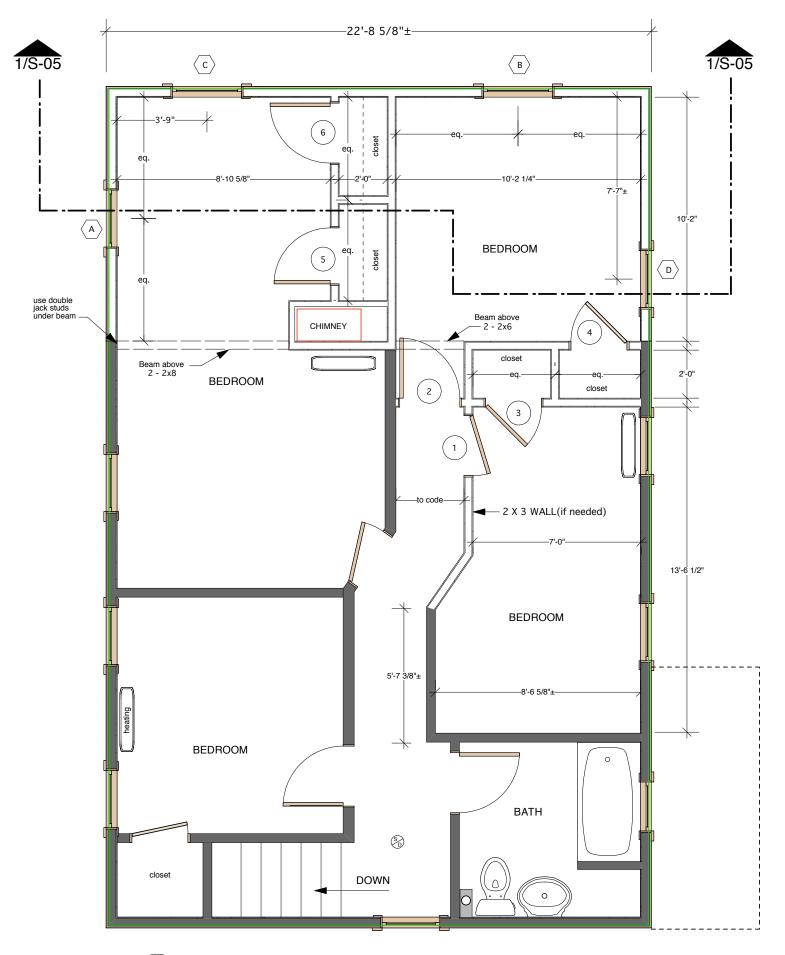

Proposed Second Floor Scale: 1/4" = 1'-0"

#### NOTES

Windows C & D on end of house meet egress standard. actual size:5.8 sq.ft...31"widex26"hiç in full open position.

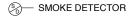

Smoke detector location to be verified by builder and by Fire dept.

All Smoke detectors to be interconnected with battery backup and CO detection.

#### Savage Residence 15 Evans Road

Needham, MA

### Roger P. Toran

DESIGN ~ BUILD

57 Mary Chilton Road Needham, Massachusetts 02492 781-444-5966 781-449-6727 FAX

Job Number: 0911

Drawn By: Roger P. Toran

Date: 20 June 2011

Revised: 20 Feb. 2012

Scale: 1/4" = 1'

# PROPOSED 2ND FLOOR PLAN



WINDOW SCHEDULE									
KEY	FLOOR	QTY.	MANUF.	MODEL #	ROUGH OPENING	TYPE	MUNTIN	ADDEND:	NOTES:
Α	2	1	ANDERSEN	TW 2442	2'-6 1/8" X 4'-4 7/8"	DH	TO MATCH EXISTING	Vinyl Low E (u34)	hdwre and finishes by owner/builder
В	2	1	ANDERSEN	TW 210410	3'-0 1/8" X 5'-0 7/8"	DH	TO MATCH EXISTING	Vinyl Low E (u34)	" EGRESS WIN.(5.8sq.ft31"widex26"high)
С	2	1	ANDERSEN	TW 210410	3'-0 1/8" X 5'-0 7/8"	DH	TO MATCH EXISTING	Vinyl Low E (u34)	" EGRESS WIN.(5.8sq.ft31"widex26"high)
D	2	1	ANDERSEN	TW 2442	2'-6 1/8" X 4'-4 7/8"	DH	TO MATCH EXISTING	Vinyl Low E (u34)	II .
E	1	1	ANDERSEN	TW 2442	2'-6 1/8" X 4'-4 7/8"	DH	TO MATCH EXISTING	Vinyl Low E (u34)	II .

DOOR SO	CHEDULE							
KEY	FLOOR	QTY.	MANUF.	MATERIAL	DOOR SIZE	TYPE	JAMB	NOTES:
1	2	1	TBD	WOOD	2'-6" X 6'-6"	LEFT HAND		hdwre and finishes by owner/builder
2	2	1	II .	п	2'-6" X 6'-6"	LEFT HAND		II .
3	2	1	11	II .	2'-4" X 6'-6"	RIGHT HAND		п
4	2	1	11	II .	2'-4" X 6'-6"	RIGHT HAND		п
5	2	1	11	II .	2'-4" X 6'-6"	LEFT HAND		п
6	2	1	"	"	2'-4" X 6'-6"	RIGHT HAND		П
7	1	1	"	"	2'-6" X TBD	POCKET		П

#### **GENERAL NOTES**

- 1. LINTELS OVER ALL WINDOWS TO BE AS SPECIFIED.
- 2. NEW FLOOR SHEATHING TO BE 3/4" CDX, APA GRADE TRADEMARKED PLYWOOD.
- 3. NEW ROOF SHEATHING TO BE 5/8" CDX, APA GRADE TRADEMARKED PLYWOOD.
- 4. NEW WALL SHEATHING TO BE 1/2" ZIP WALL SHEATHING, APA GRADE TRADEMARKED.
- 5. ALL FRAMING AND NAILING SHALL CONFORM TO THE LATEST MASSACHUSETTS STATE BUILDING CODE.
- 6. ALL NEW EXTERIOR WALL CONSTRUCTION TO BE 2 X 4 STUDS AT 16" ON CENTER. PROVIDE TYVEK OR EQUAL BUILDING PAPER OVER 1/2" "ZIPWALL SHEATHING. ALL JOINTS TO BE BLOCKED AND NAILED TO CODE.
- 7. ALL NEW INTERIOR WALL CONSTRUCTION TO BE 2 X 4 STUDS AT 16" ON CENTER.
- 8. INSULATE ALL EXTERIOR WALLS WITH A MINIMUM OF R-19; PROVIDE VAPOR BARRIER.
- 9. NEW FIRST FLOOR JOISTS TO BE 2 X 8 KD.

- 10. NEW 2ND FLOOR JOISTS TO BE 2 X 10 KD.
- 11. ANY NEW SILLS ON THE FOUNDATION SHALL BE PRESSURE TREATED LUMBER.
- 12. INTERIOR WALL AND CEILING FINISH TO BE 1/2" PLASTER-BASE (BLUEBOARD) AND 1/8" MINIMUM SKIM-COAT PLASTER. WALL PLASTER FINISHES TO BE SMOOTH. CEILINGS TO BE SMOOTH. CLOSETS CAN BE TEXTURED.
- 13. ALL SECOND FLOOR CEILINGS TO BE INSULATED TO A MIN. R-30 INSULATION VALUE.
- 14. ALL NEW EXTERIOR WALLS TO BE INSULATED TO AN R-19 INSULATION VALUE.
- 15. ALL 1/2" 'ZIPWALL SHEATHING MUST BE BLOCKED AT ALL SEAMS AND NAILED ACCORDING TO NEW WALL BRACED SHEATHING DIAGRAMS IN MA CODE BOOK.
- 15. ALL WOOD SHALL BE SPRUCE-PINE-FIR NO. 2 OR BETTER, WITH AN ALLOWABLE BENDING STRESS -- 1000 PSI REPETATIVE USAGE, NORMAL LOADING.

#### Savage Residence 15 Evans Road

Needham, MA

#### Roger P. Toran

DESIGN ~ BUILD

57 Mary Chilton Road Needham, Massachusetts 02492 781-444-5966 781-449-6727 FAX

Job Number: 0911

Drawn By: Roger P. Toran

Date: 20 June 2011


Revised: 20 Feb. 2012

Scale: 1/4" = 1'

#### D/W Schedule General Notes





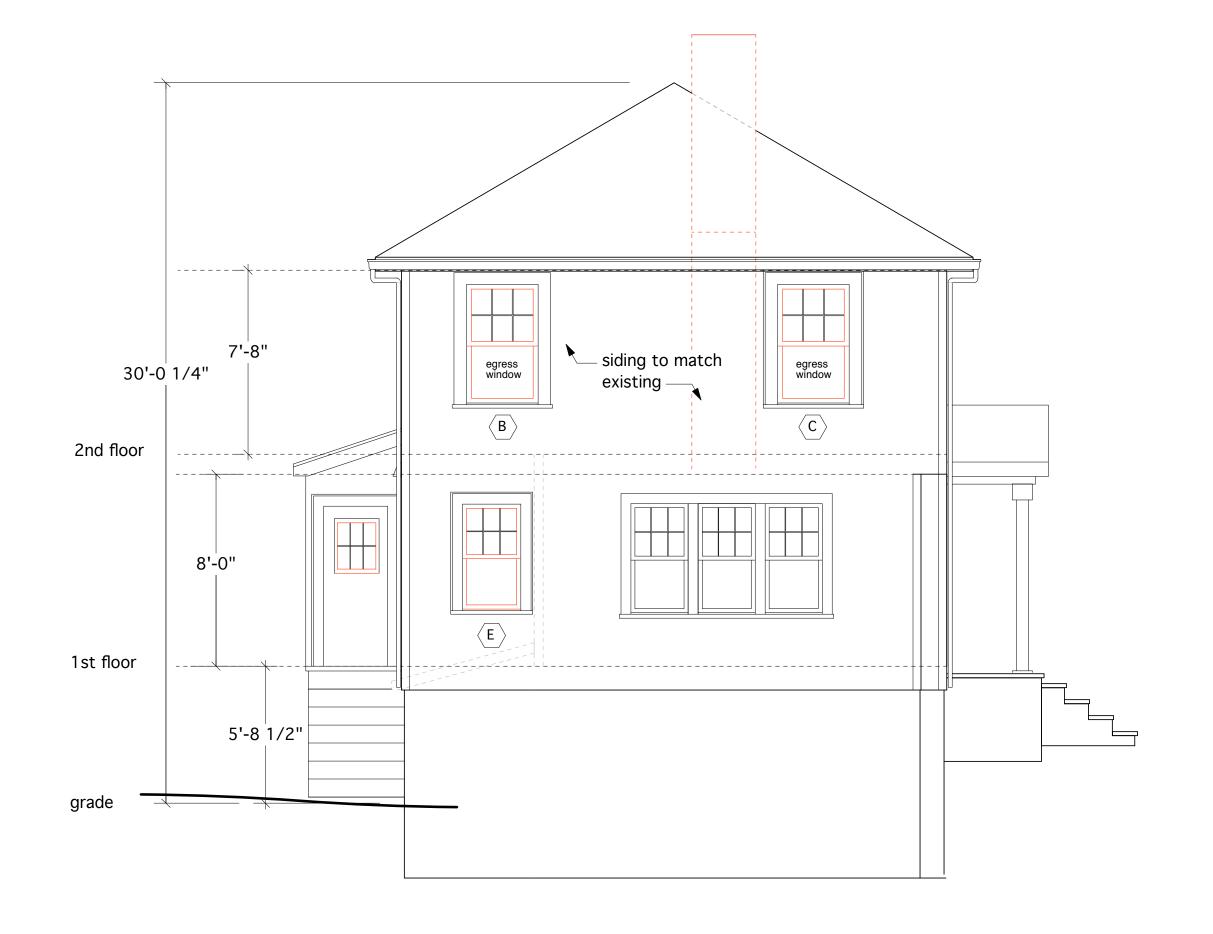

Savage Residence

15 Evans Road

Needham, MA

## Roger P. Toran

DESIGN ~ BUILD

57 Mary Chilton Road Needham, Massachusetts 02492 781-444-5966 781-449-6727 FAX

Job Number: 0911

Drawn By: Roger P. Toran


Date: 20 June 2011

Revised: 20 Feb. 2012

Scale: 1/4" = 1'

LEFT ELEVATION

Left Elevation Scale: 1/4" = 1'-0"

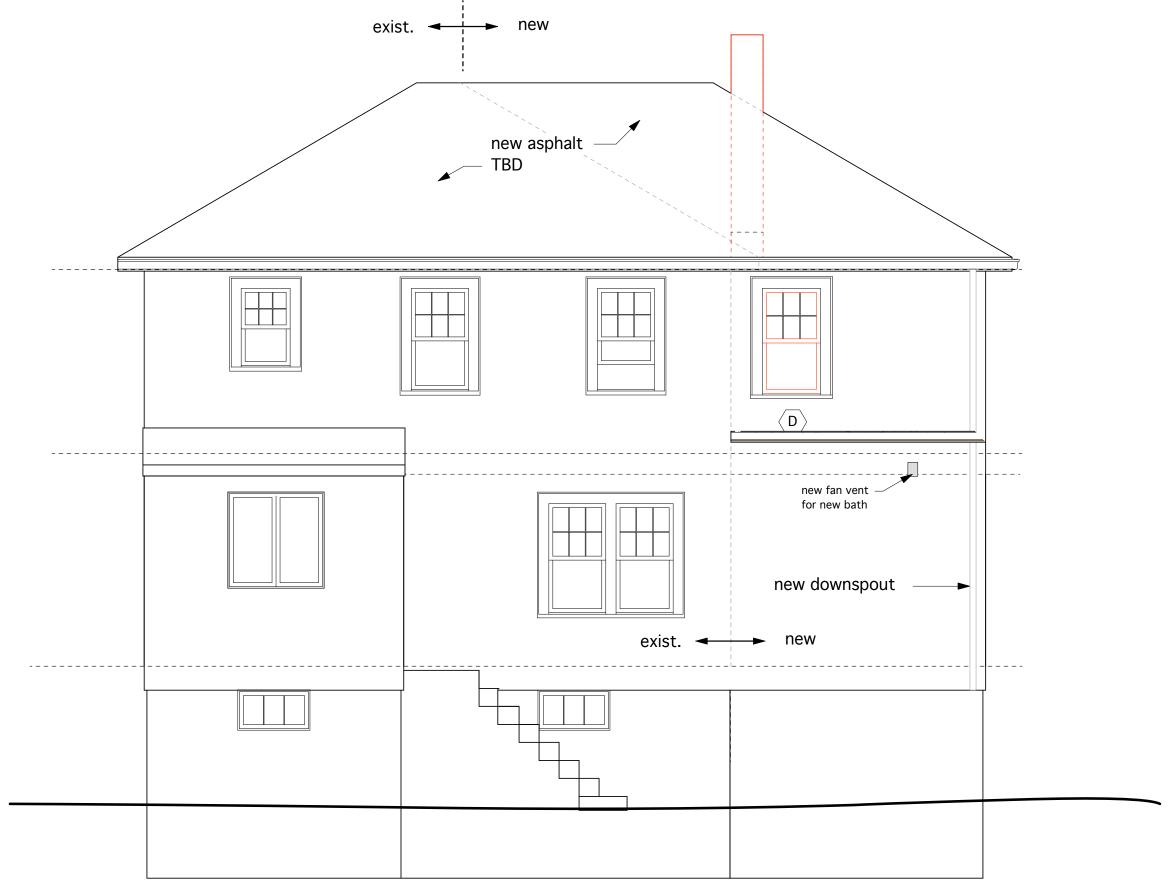

Savage Residence

15 Evans Road

Needham, MA

Roger P. Toran

DESIGN ~ BUILD

57 Mary Chilton Road Needham, Massachusetts 02492 781-444-5966 781-449-6727 FAX

Job Number: 0911

Drawn By: Roger P. Toran

Date: 20 June 2011

Revised: 20 Feb. 2012

Scale: 1/4" = 1'

REAR ELEVATION

Rear Elevation Scale: 1/4" = 1'-0"

ANY NEW WOOD IN CONTACT WITH FOUNDATION TO BE PRESSURE TREATED. USE ONLY APPROVED CONNECTORS.

#### Savage Residence 15 Evans Road

Needham, MA

### Roger P. Toran

DESIGN ~ BUILD

57 Mary Chilton Road Needham, Massachusetts 02492 781-444-5966 781-449-6727 FAX

Job Number: 0911

Drawn By: Roger P. Toran


Date: 20 June 2011


Revised: 20 Feb. 2012

Scale: 1/4" = 1'

#### 1ST FLOOR FRAMING



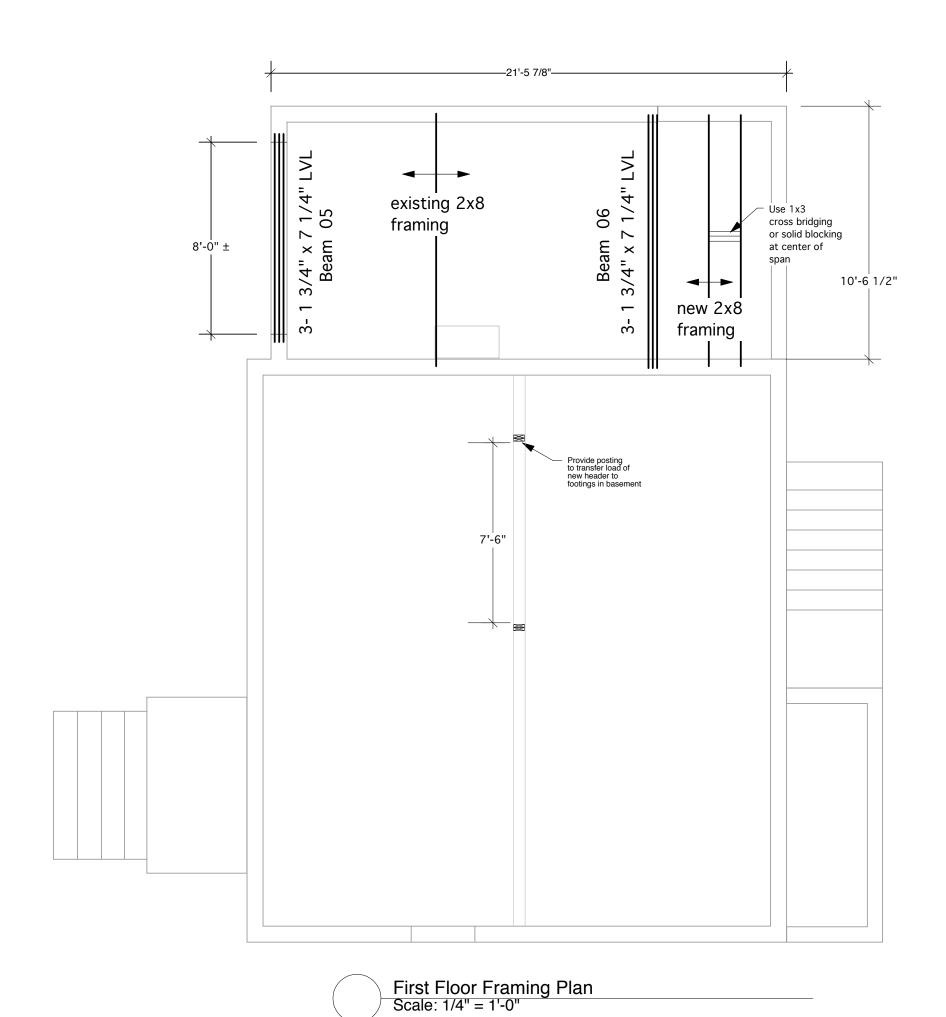

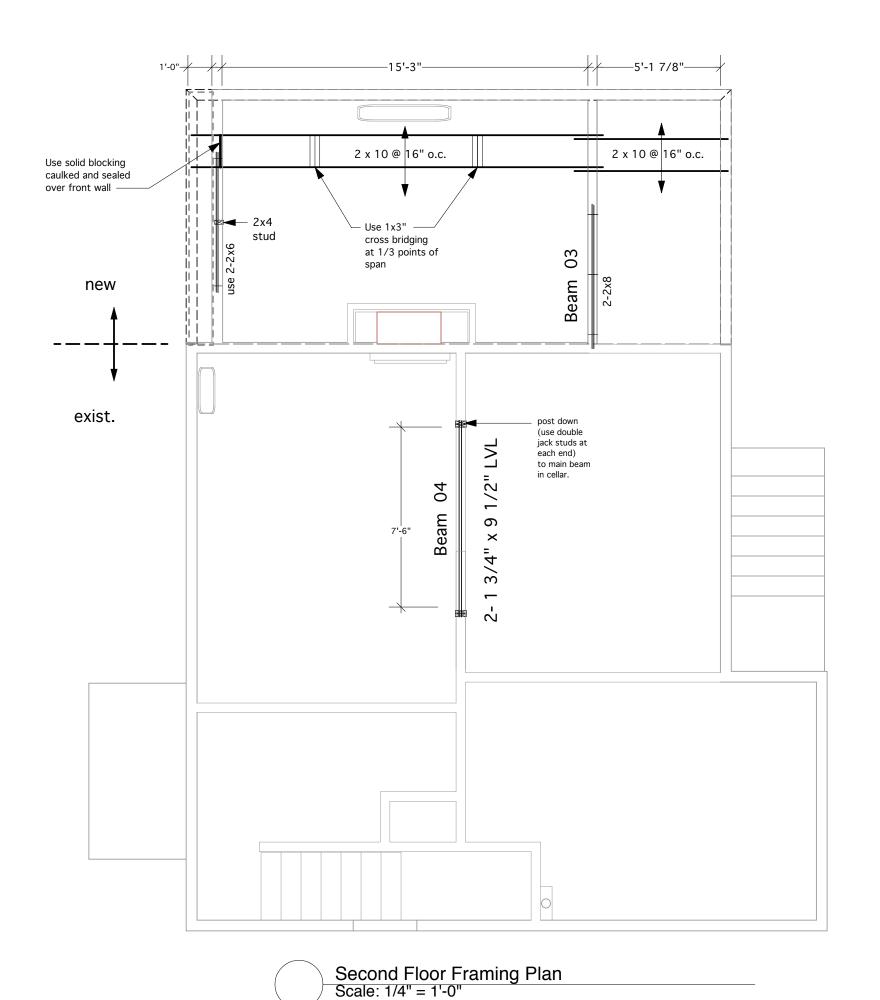

Needham, MA

## Roger P. Toran

DESIGN ~ BUILD

57 Mary Chilton Road Needham, Massachusetts 02492 781-444-5966 781-449-6727 FAX

Job Number: 0911

Drawn By: Roger P. Toran


Date: 20 June 2011

Revised: 20 Feb. 2012

Scale:


2ND FLOOR FRAMING



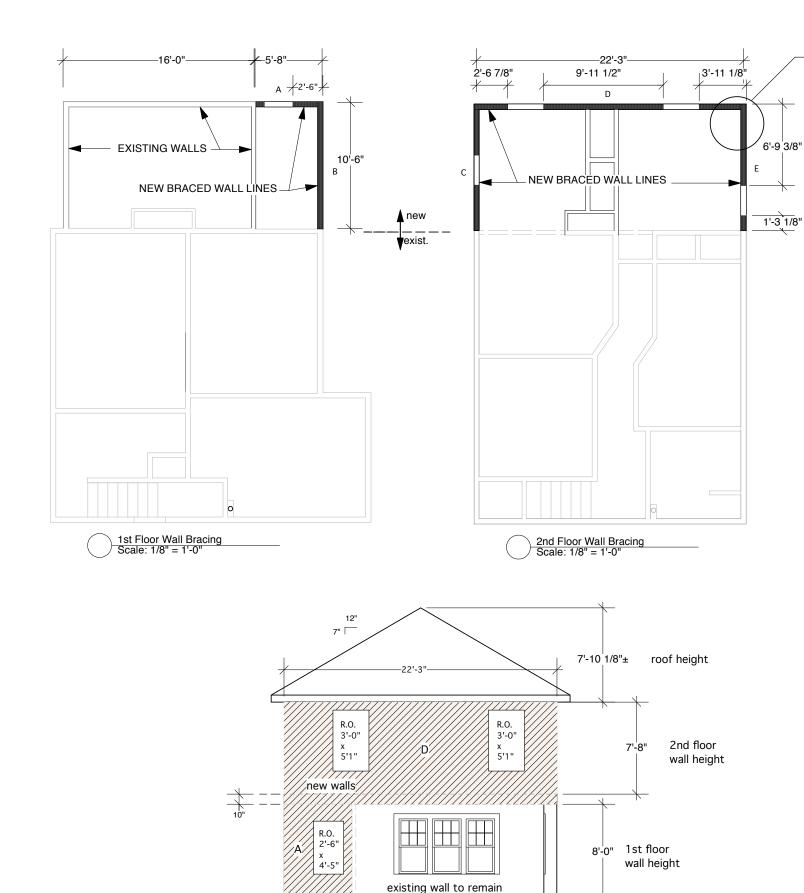


Area of CS-WSP - Left Elevation Scale: 1/8" = 1'-0"

-16**'-**0''-

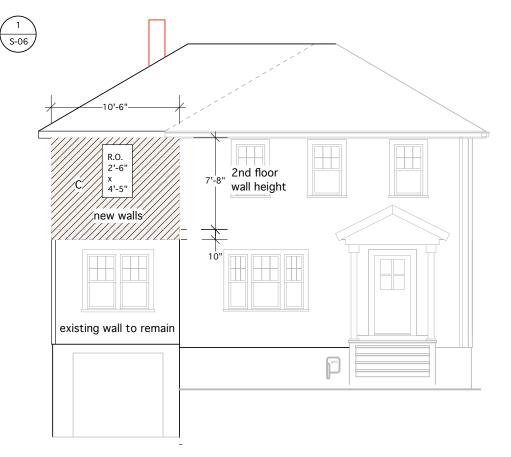

#### Area of CS-WSP - Front Elevation Scale: 1/8" = 1'-0"

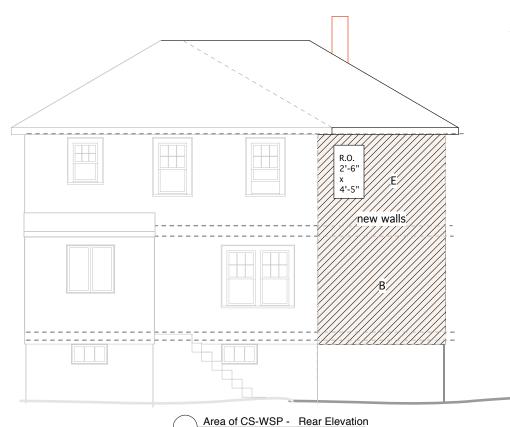

Scale: 1/8" = 1'-0"

# SEE SWANSON STRUCTURAL INC. LETTER REPORT; 2/18/12

wall bracing method: CS-WSP

Braced wall % for CS-WSP method, first and second story must be 16% or greater.

CALCS:

Wall A 
$$\frac{6' \times 12}{2.5' \times 12}$$
  $\times 100 = 41.6\%$ 

Wall B  $\frac{10.5' \times 12}{10.5' \times 12}$   $\times 100 = 100\%$ 

Wall C  $\frac{10.5' \times 12}{8' \times 12}$   $\times 100 = 76\%$ 

Wall D  $\frac{23' \times 12}{16' \times 12}$   $\times 100 = 69\%$ 

Wall E  $\frac{10.5' \times 12}{8' \times 12}$   $\times 100 = 76\%$ 

USE 1/2" 4' X10' ZIP WALL SHEATHING. INSTALL VERTICALLY FROMTOP PLATE TO FLOOR JOIST MUST BE BLOCKED AT ALL SEAMS AND NAILED ACCORDING TO NEW WALL BRACED SHEATHING DIAGRAMS IN MA CODE BOOK.

#### Savage Residence 15 Evans Road

Needham, MA

## Roger P. Toran

DESIGN ~ BUILD

57 Mary Chilton Road Needham, Massachusetts 02492 781-444-5966 781-449-6727 FAX

Job Number: 0911


Drawn By: Roger P. Toran

Date: 20 June 2011

Revised: 20 Feb. 2012

Scale: 1/8" = 1'

WALL BRACING PLAN

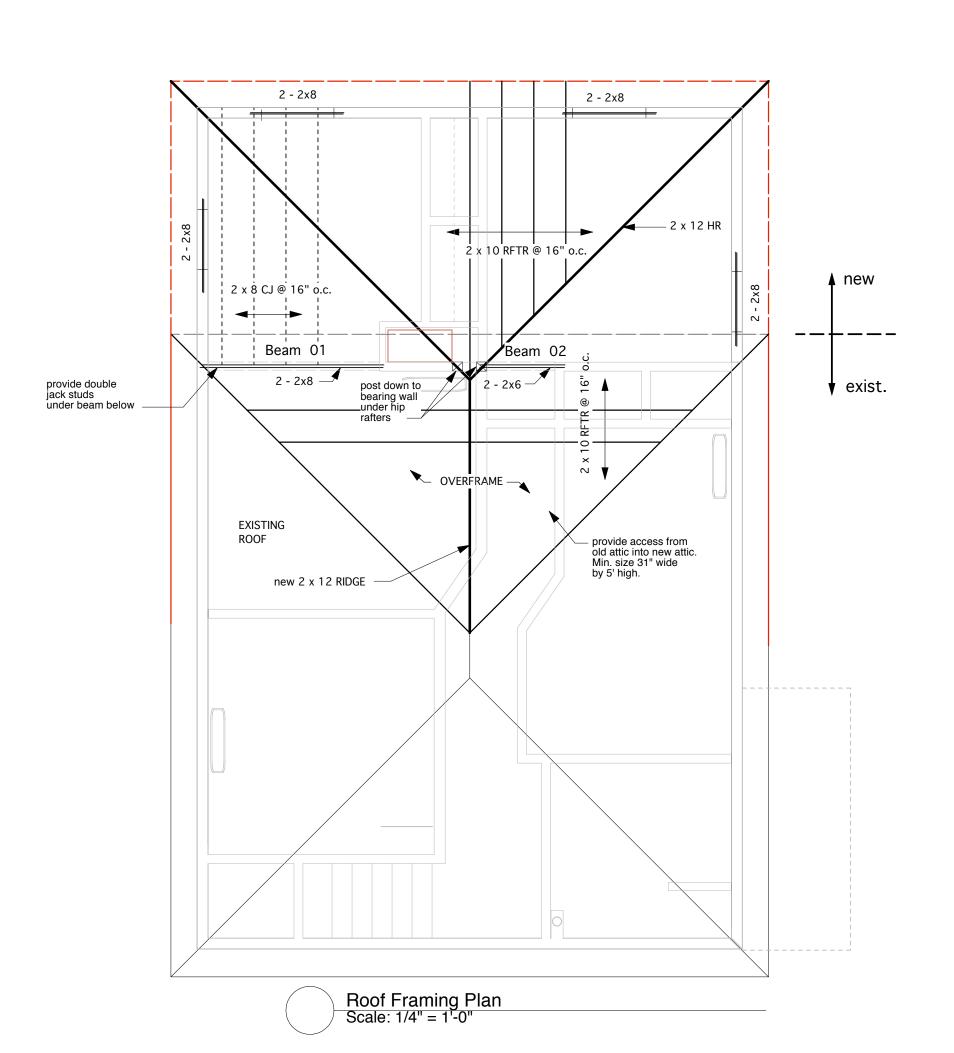

Needham, MA

## Roger P. Toran

DESIGN ~ BUILD

57 Mary Chilton Road Needham, Massachusetts 02492 781-444-5966 781-449-6727 FAX

Job Number: 0911

Drawn By: Roger P. Toran

Date: 20 June 2011

Revised: 20 Feb. 2012

Scale:

#### ROOF FRAMING





Existing conditions of garage foundation verified by contractor and structural engineer. Existing foundation is 4' below grade.

#### Savage Residence 15 Evans Road

Needham, MA

## Roger P. Toran

DESIGN ~ BUILD

57 Mary Chilton Road Needham, Massachusetts 02492 781-444-5966 781-449-6727 FAX

Job Number: 0911

Drawn By: Roger P. Toran


Date: 20 June 2011

Revised: 20 Feb. 2012


Scale: 1/4" = 1'

**SECTION A-A** 




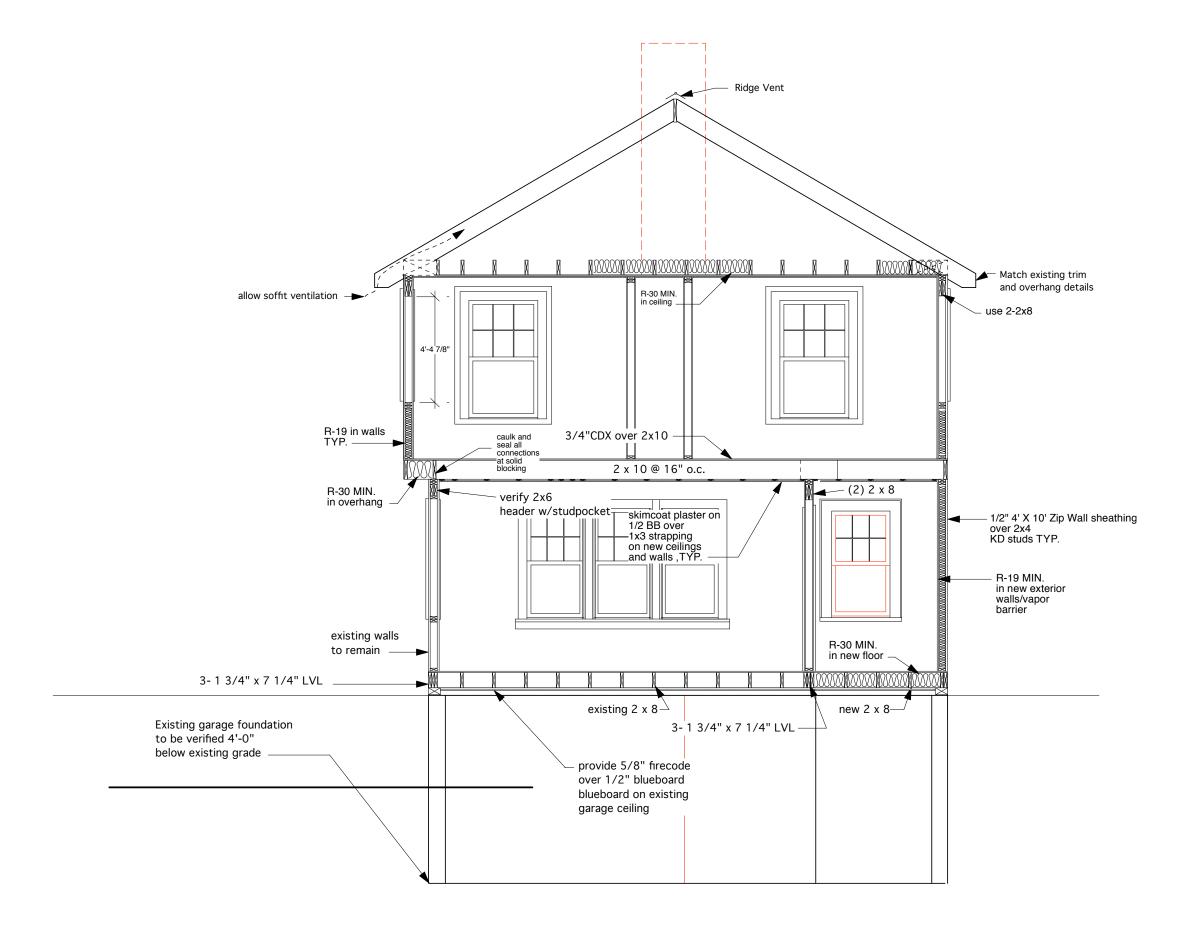

SECTION A - A
Scale: 1/4" = 1'-0"

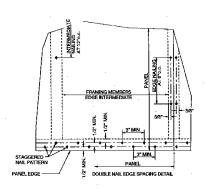

Detail
Vertical and Horizontal Nailin
for Panel Attachment

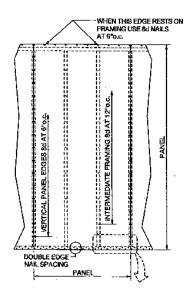

Vertical and Horizontal Nailing for Panel Attachment

Wood Structural Panels shall be minimum thickness of 7/16" and be installed as follows:

Panels shall be installed with strength axis parallel to studs.

All horizontal joints shall occur over and be nailed to framing. Add blocking where needed as per code. On single story construction, panels shall be attached to bottom plates and top member of the double top plate. On two story construction, upper panels shall be attached to the top member of the upper double top plate and to band joist at bottom of panel. Upper attachment of lower panel shall be made to band joist and lower attachment made to lowest plate at first floor framing.

Horizontal nail spacing at double top plates, band joists, and girders shall be a double row of 8d staggered at 3 inches on center.

#### **CORNER FRAMING** Corners of braced wall lines with continuous sheathing must be framed as shown in orientation of studs 8d common (0.131" x 2-1/2") @ 6" o.c. on all may vary; see Figure R602.3(2) panel edges minimum 24" wood structural panel orientation of studs may sheathing vary; see Figure R602.3(2) braced wall line with 16d nail (0.131" x -16d nail (0.131" x continuous sheathing 3-1/2") @ 12" o.c. 3-1/2") @ 12" o.c. -8d common (0.131" x gypsum wall board as required -2-1/2") @ 12" o.c. on all 8d common (0.131" x and installed in accordance with 2-1/2") @ 6" o.c. on all intermediate supports Chapter 7 panel edges 8d common nails (0.131" optional non-structural minimum 24" wood x 2-1/2") @ 6" o.c. on all filler panel structural panel sheathing panels' edges -braced wall line with 8d common nails (0.131" x continuous sheathing 2-1/2") at 6" o.c., on all -8d common (0.131" x 2-1/2") panels' edges @ 12" o.c. on all intermediate

Scale: 1/4" = 1'

WALL BRACING DETAILS

Savage Residence

Roger P. Toran

781-444-5966

Job Number: 0911

781-449-6727 FAX

Date: 20 June 2011

Revised: 20 Feb. 2012

Drawn By: Roger P. Toran

57 Mary Chilton Road

Needham, Massachusetts 02492

DESIGN ~ BUILD

15 Evans Road

Needham, MA

Braced Wall Framing Detail